

ENGINEERING, LLC
SURVEYING • ENVIRONMENTAL • LAB/CMT

SURVEYING • ENVIRONMENTAL • LAB/CMT

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SAN ANGELO, TEXAS 76903
FIRM REGISTRATION NUMBER F-7608 & 10102400 www.skge.com

OF SAN ANELO EST COLLEGE ANGELO, TEXAS

## NEW BOAT RAMP LAKE NASWORTHY SAN ANGELO, TEXAS

SITE LAYOUT PLAN


DWG BY:
RTG

DWG. DATE:
07.30.2015

JOB NO.
14-E-0804

SCALE:
1"=20'

C1.1

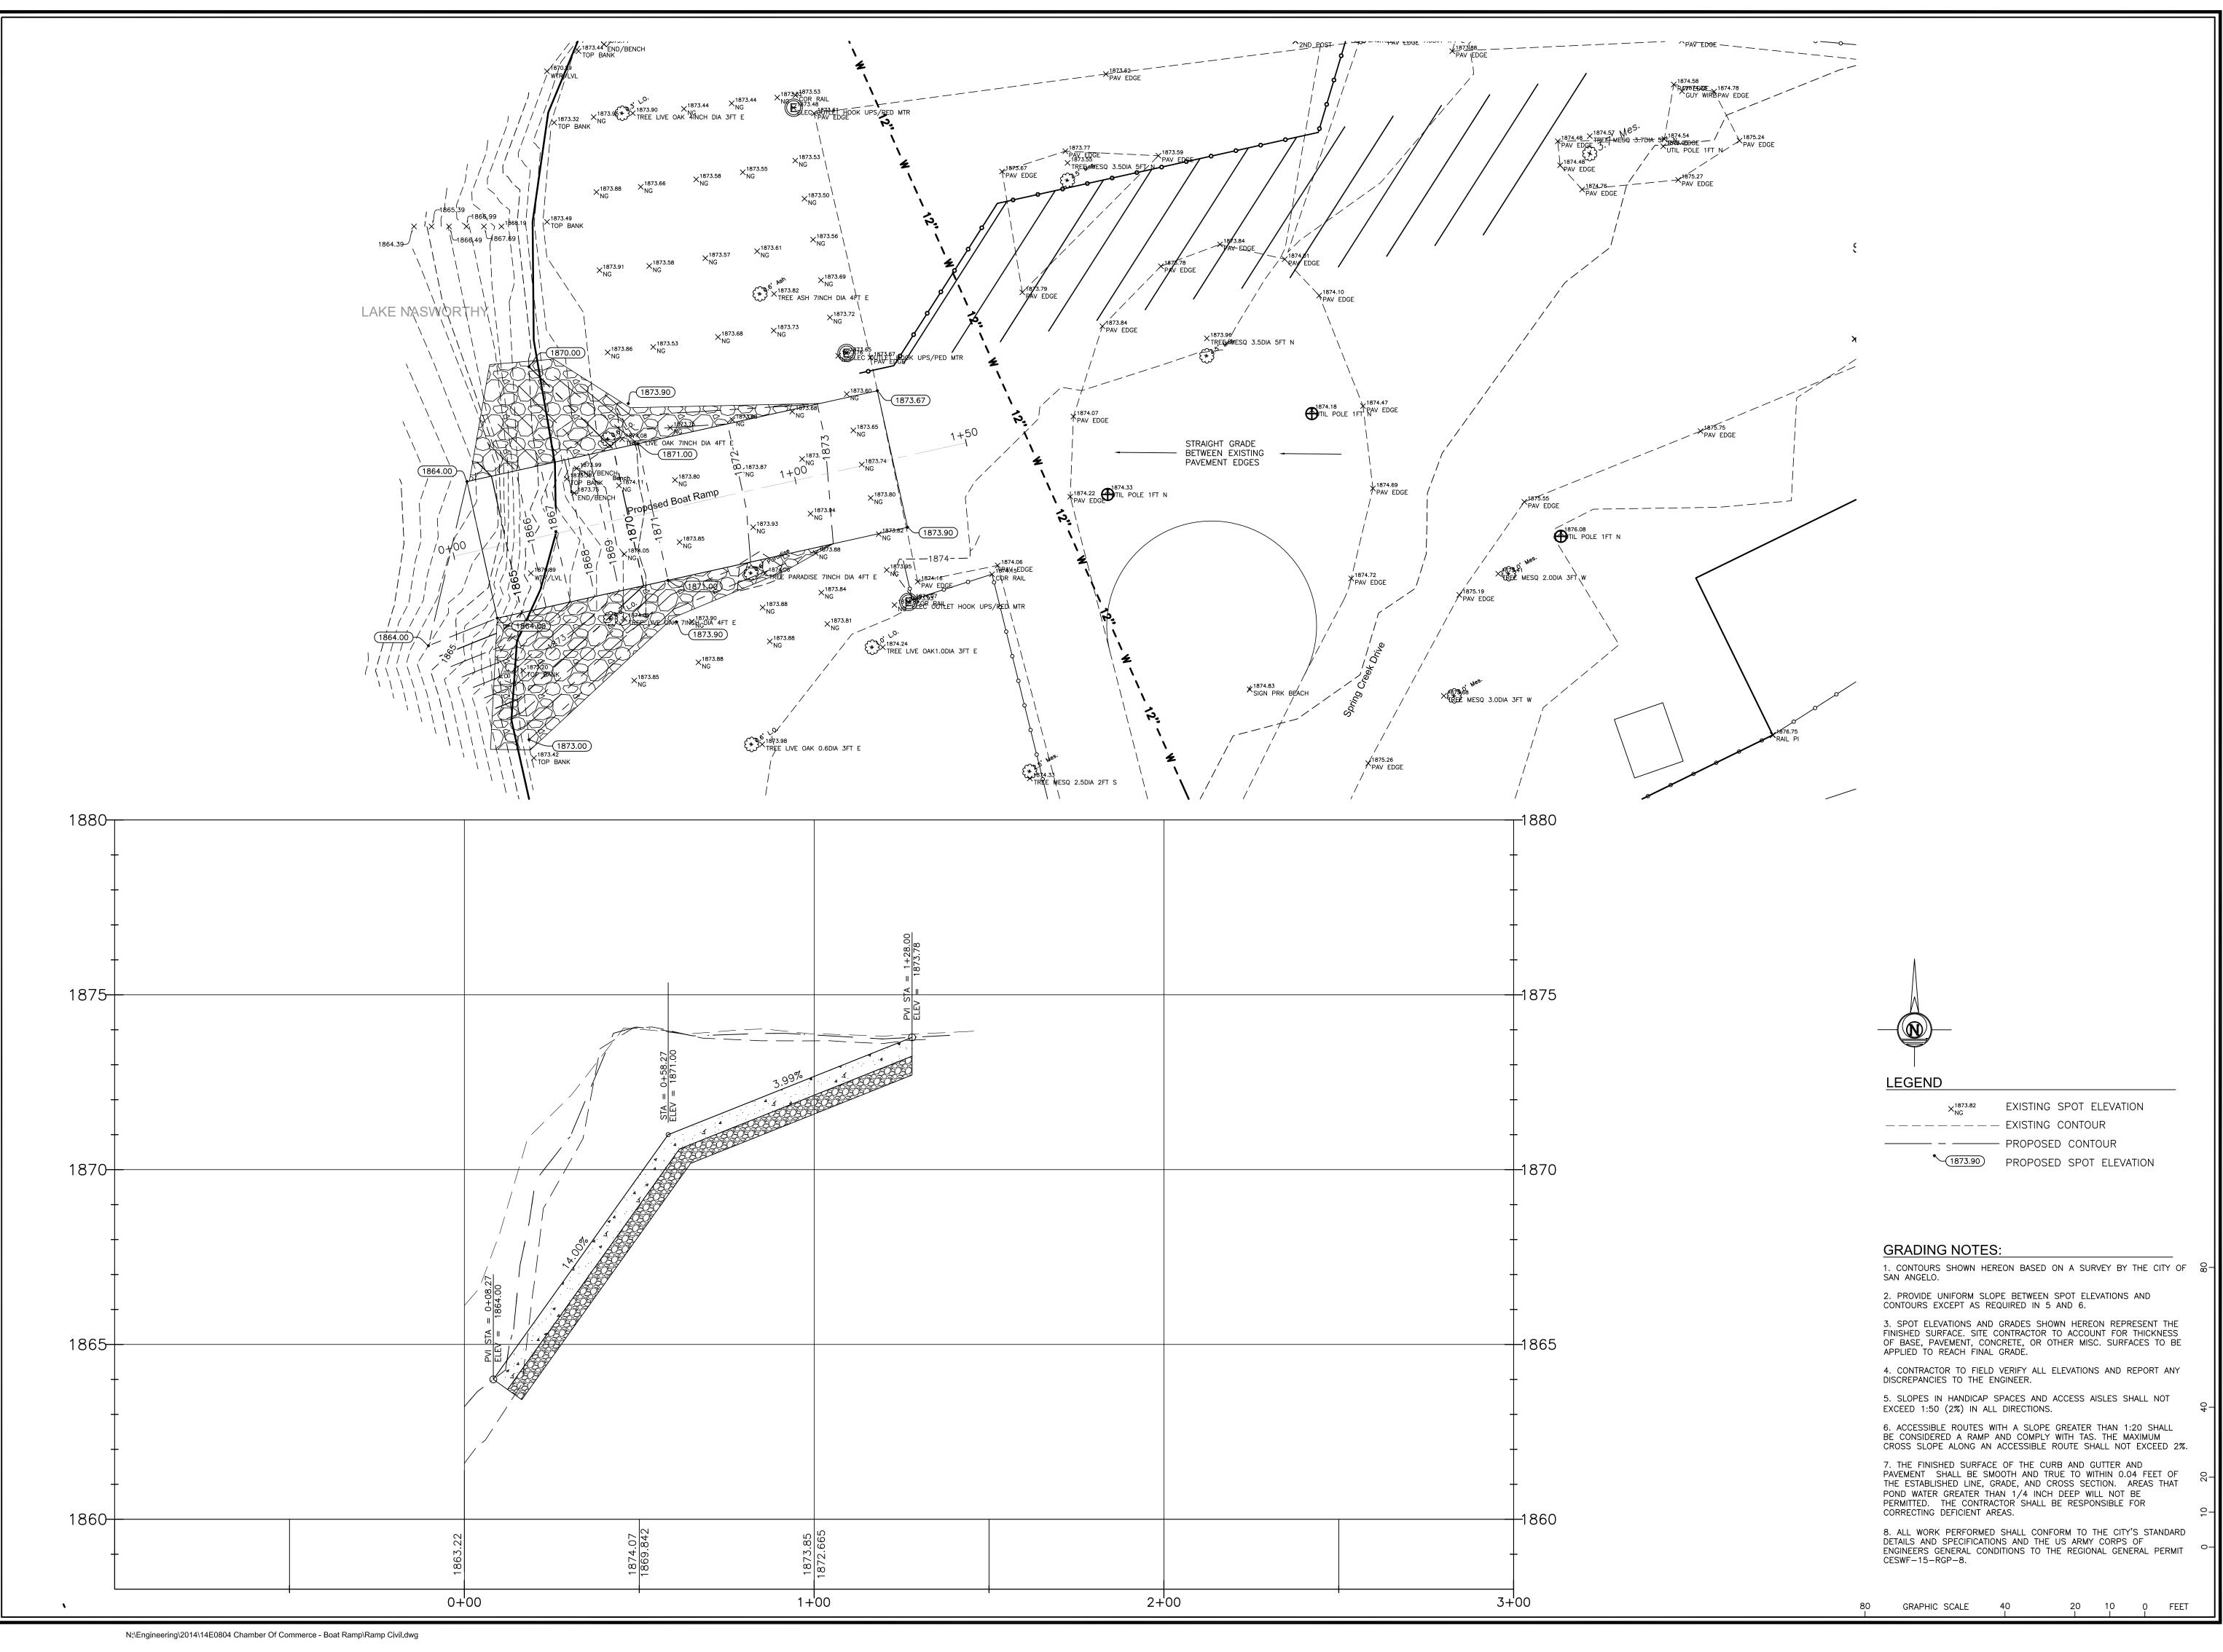

ENGINEERING, LLC
SURVEYING • ENVIRONMENTAL • LAB/CMT
SURVEYING • ENVIRONMENTAL • ENVIRONMENTAL

CITY OF SAN ANELO 52 WEST COLLEGE SAN ANGELO, TEXAS

NEW BOAT RAMP LAKE NASWORTHY SAN ANGELO, TEXA

SITE GRADING PLAN

DWG BY:
RTG

DWG. DATE:
07.30.2015

JOB NO.
14-E-0804

SCALE:
C2.1

2" HOT MIX ASPHALT—
PRIME COAT—

PRIME COAT—

6" COMPACTED BASE—

8" COMPACTED SUBGRADE—


1. HOT MIX ASPHALT: TxDOT ITEM 340, TYPE D, PER COSA TECHNICAL SPECIFICATION ITEM 340.

2. PRIME COAT: MC-30 AT RATE OF 0.20 GAL/SQ. YD. PER COSA TECHNICAL SPECIFICATION ITEM 300 & 310.

3. COMPACTED BASE: CRUSHED LIMESTONE PER TXDOT ITEM 247, TYPE A, GRADE 2. COMPACT TO AT LEAST 97% MODIFIED PROCTOR DENSITY PER COSA TECHNICAL SPECIFICATION ITEM 247.

4. COMPACTED SUBGRADE: SCARIFY, MOISTURE CONDITION, AND COMPACT THE TOP 8" TO AT LEAST 95% STANDARD PROCTOR DENSITY AT A MOISTURE CONTENT WITHIN  $\pm 2\%$  POINTS OF THE OPTIMUM MOISTURE CONTENT PER COSA TECHNICAL SPECIFICATION ITEM 200.

HMAC PAVEMENT
SECTION
NO SCALE

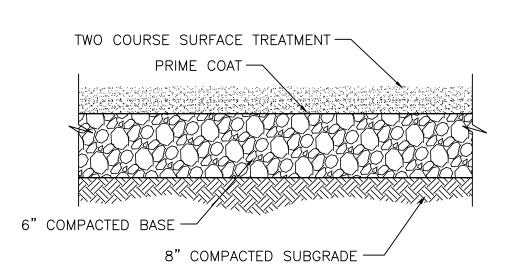

1. FIRST COURSE: AC-15P @ 0.50 GAL/SQ. YD. & PB GRADE 3 @ 1 CU. YD./85 SQ. YD. SECOND COURSE: AC-15P @ 0.35 GAL/SQ. YD. & PB GRADE 5 @ 1 CU. YD./100 SQ. YD. PER COSA ITEM 316.

2. PRIME COAT: MC-30 AT RATE OF 0.20 GAL/SQ. YD. PER COSA TECHNICAL SPECIFICATION ITEM 300 & 310.

3. COMPACTED BASE: CRUSHED LIMESTONE PER TxDOT ITEM 247, TYPE A, GRADE 2. COMPACT TO AT LEAST 97% MODIFIED PROCTOR DENSITY PER COSA TECHNICAL SPECIFICATION ITEM 247.

4. COMPACTED SUBGRADE: SCARIFY, MOISTURE CONDITION, AND COMPACT THE TOP 8" TO AT LEAST 95% STANDARD PROCTOR DENSITY AT A MOISTURE CONTENT WITHIN  $\pm 2\%$  POINTS OF THE OPTIMUM MOISTURE CONTENT PER COSA TECHNICAL SPECIFICATION ITEM 200.

TWO COURSE
SECTION
NO SCALE

ENGINEERING, LLC
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CITY OF SAN ANELO 52 WEST COLLEGE SAN ANGELO, TEXAS

THE SEAL APPEARING ON THIS DRAWING WAS AUTHORIZED BY RUSSELL T. GULLY, P.E. 87727 SKG ENGINEERING, LLC #F-7608 JULY 30, 2015

LAKE NASWORTHY
SAN ANGELO, TEXAS

SITE DETAILS

SIONS	
1	
DWG. DATE:	
07.30.2015	
SHEET NO.	
C3.1	